

PLANNING NOTICE

An application has been received for a Permit under s.57 of the Land Use Planning Approvals Act 1993:

APPLICANT:	Woolcott Land Services - PA\26\0117
PROPERTY ADDRESS:	60 Veterans Row WESTBURY (CT: 188905/3)
DEVELOPMENT:	Single dwelling & Residential outbuildings
	(shipping container, sheds) & rainwater
	tank - setbacks, driveway, parking area.

The application can be inspected until **Monday, 1 December 2025**, at <u>www.meander.tas.gov.au</u> or at the Council Office, 26 Lyall Street, Westbury (during normal office hours).

Written representations may be made during this time addressed to the General Manager, PO Box 102, Westbury 7303, or by email to planning@mvc.tas.gov.au. Please include a contact phone number. Please note any representations lodged will be available for public viewing.

If you have any questions about this application please do not hesitate to contact Council's Planning Department on 6393 5320.

Dated at Westbury on 15 November 2025.

Jonathan Harmey

GENERAL MANAGER

APPLICATION FORM



PLANNING PERMIT

Land Use Planning and Approvals Act 1993


- Application form & details MUST be completed **IN FULL**.
- Incomplete forms will not be accepted and may delay processing and issue of any Permits.

T-		OFFICE USE OINLY		
Property No:	Assessment No:] - <u> </u>		
DA\	PA\	PC\		
Have you alread	on the result of an illegal building work? y received a Planning Review for this proposal? access or crossover required?	YesNoIndicate by ✓ boxYesNoYesNo		
PROPERTY DET	TAILS:			
Address:	60 Veterans Row	Certificate of Title: 188905		
Suburb:	Westbury	Lot No: 3		
Land area:	Refer to report	m^2 / ha		
Present use of land/building:	Vacant	(vacant, residential, rural, industrial, commercial or forestry)		
• •	 Does the application involve Crown Land or Private access via a Crown Access Licence: ☐ Yes ☑ No Heritage Listed Property: ☐ Yes ☑ No 			
DETAILS OF US	E OR DEVELOPMENT:			
Indicate by ✓ box	Building work Change of use Forestry Other	Subdivision Demolition		
Total cost of develo	spment \$ 397,170.00 Includes total cost of	f building work, landscaping, road works and infrastructure		
Description of work:	Building and works – development of a single	e dwelling and outbuiling		
Use of building:		ise of proposed building – dwelling, garage, farm building, , office, shop)		
New floor area:	Refer to report m ² New building height:	m		
Materials:	External walls:	Colour:		
	Roof cladding:	Colour:		



RESULT OF SEARCH

RECORDER OF TITLES

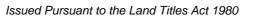



SEARCH OF TORRENS TITLE

VOLUME 188905	FOLIO 3
EDITION	DATE OF ISSUE
2	25-Aug-2025

SEARCH DATE : 02-Sep-2025 SEARCH TIME : 11.52 AM

DESCRIPTION OF LAND

Town of WESTBURY

Lot 3 on Sealed Plan 188905

Derivation: Part of Lot 72, Sec. C11, 5A-OR-OP Gtd. to

Michael Brennan
Prior CT 122378/72

SCHEDULE 1

N275091 TRANSFER to MICHAEL WAYNE SPAULDING and JOH RUBY SPAULDING Registered 25-Aug-2025 at 12.01 PM

SCHEDULE 2

Reservations and conditions in the Crown Grant if any SP188905 FENCING PROVISION in Schedule of Easements E429224 MORTGAGE to MyState Bank Limited Registered 25-Aug-2025 at 12.02 PM

UNREGISTERED DEALINGS AND NOTATIONS

No unregistered dealings or other notations

Page 1 of 1




FOLIO PLAN

RECORDER OF TITLES



Issued Pursuant to the Land Titles Act 1980

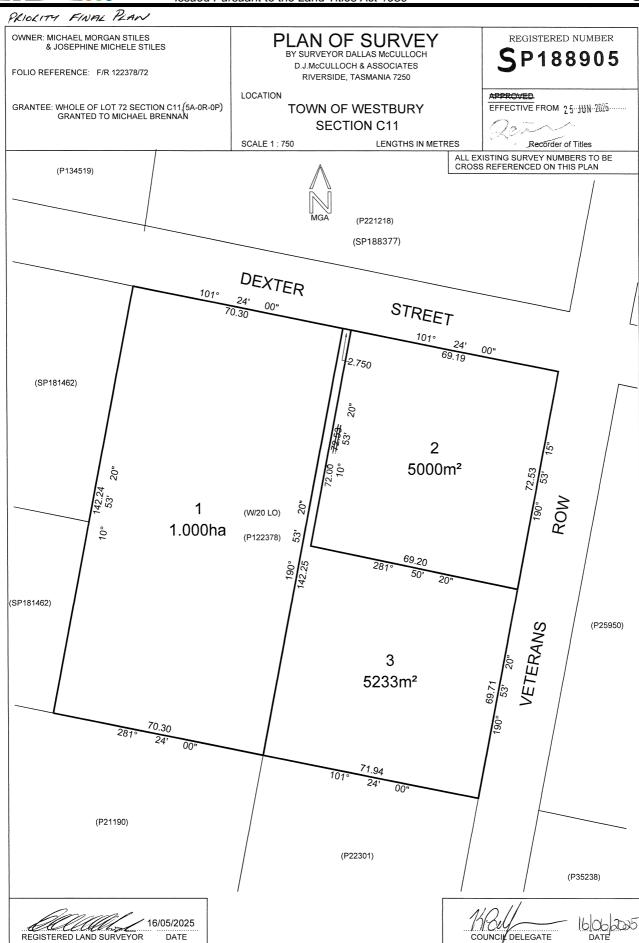

Page 1 of 1 Search Date: 02 Sep 2025 Search Time: 11:52 AM Volume Number: 188905 Revision Number: 01

DATE



SCHEDULE OF EASEMENTS

RECORDER OF TITLES

Issued Pursuant to the Land Titles Act 1980



SCHEDULE OF EASEMENTS

THE SCHEDULE MUST BE SIGNED BY THE OWNERS NOTE:

& MORTGAGEES OF THE LAND AFFECTED.

SIGNATURES MUST BE ATTESTED.

Registered Number

1889

PAGE 1 OF 1 PAGE/S

EASEMENTS AND PROFITS

Each lot on the plan is together with:-

- such rights of drainage over the drainage easements shown on the plan (if any) as may be necessary to drain the stormwater and other surplus water from such lot; and
- any easements or profits a prendre described hereunder. Each lot on the plan is subject to:-
- such rights of drainage over the drainage easements shown on the plan (if any) as passing through such lot as may be necessary to drain the stormwater and other surplus water from any other lot on the plan; and
- any easements or profits a prendre described hereunder.

The direction of the flow of water through the drainage easements shown on the plan is indicated by arrows.

PROVISION FENCING COVENANT

The Vendor Michael Morgan Stiles and Josephine Michele Stiles shall not be required to fence.

SIGNED by MICHAEL MORGAN STILES as registered proprietor of the property comprised in Folio of the Register Volume 122378 Folio 72 in the presence of:

(witness occupation) DHARMACIST

(witness address)

(witness signature)

(witness full name) MARTIN DENNIS EADE Name: MARTIN ENDE ex-officio Commission for Daylandibilis

GLDE TUDOR PHARMACY

Westbury Road Prospect Tas. 7250

SIGNED by JOSEPHINE MICHELE STILES as registered proprietor of the property comprised in Folio of the Register Volume 122378

Folio 72 in the presence of:

(witness signature)

(witness full name)

(witness occupation)

(witness address)

Name MARTIN DENNIS ex-officio Commission for Declarations

OLDE TUDOR PHARMACY

Westbury Road Frospect Tu. 7250

(USE ANNEXURE PAGES FOR CONTINUATION)

SUBDIVIDER: MICHAEL MORGAN STILES &

JOSEPHINE MICHELE STILES 122378/72 FOLIO REF:

SOLICITOR

& REFERENCE: AK GOSS - Rae & Partners Lawyers

PLAN SEALED BY: Meander Valley Council

PA12315


REF NO.

Council Delegate

NOTE: The Council Delegate must sign the Certificate for the purposes of identification.

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Page 1 of 1 Search Time: 11:52 AM Volume Number: 188905 Revision Number: 01 Search Date: 02 Sep 2025



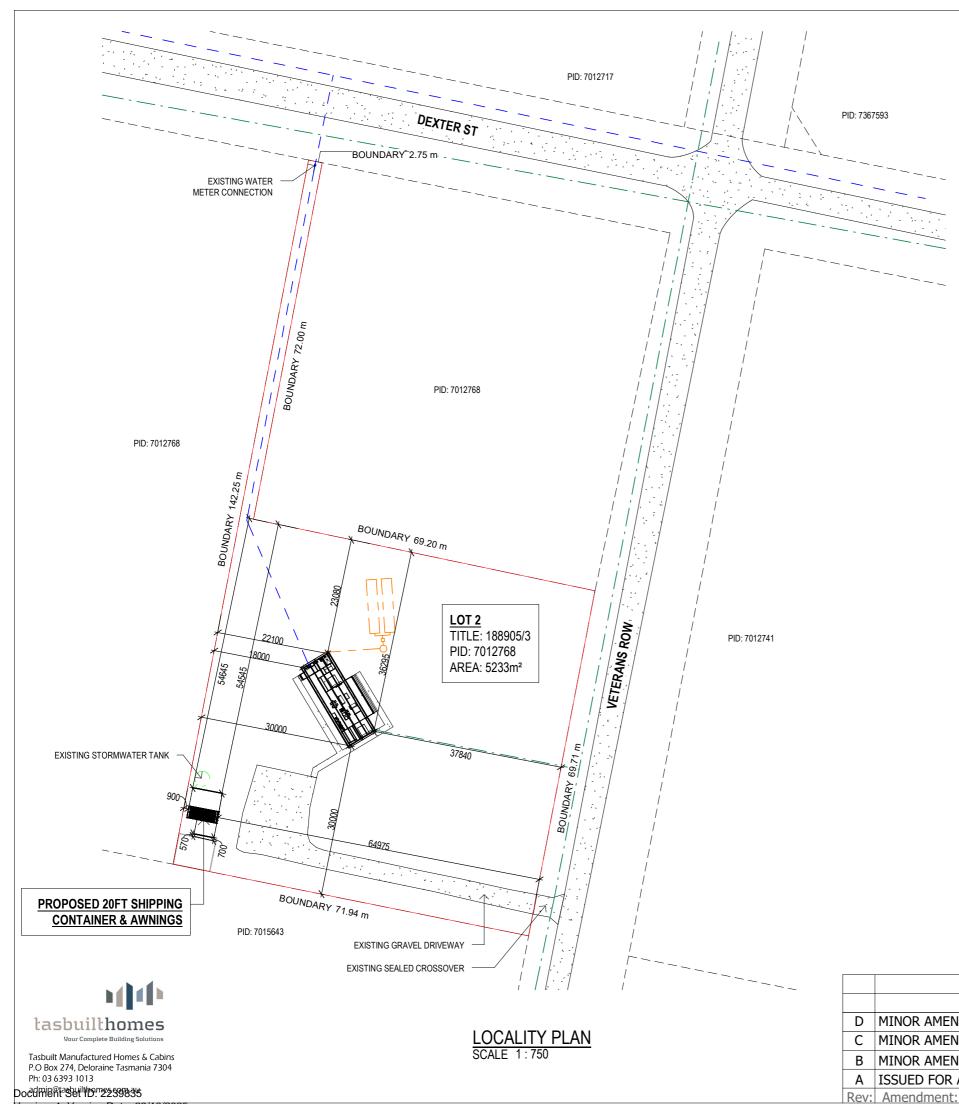



SIGN SIMILAR TO ABOVE PICTURE TO BE PERMANENTLY FIXED TO THE STATIC WATER SUPPLY
- SIGN SIZE DIMENSIONS

- MIN. 300mm x 300mm

 - LETTERING TO BE UPPERCASE AND NOT LESS THAN 100mm

A MODIFIED 4C ACCESS ROAD IS AN ALL-WEATHER ROAD WHICH COMPLIES WITH THE AUSTRALIAN ROAD RESEARCH BOARD "UNSEALED ROADS MANUAL - GUIDELINES TO GOOD PRACTICE", 3RD EDITION, MARCH 2009 AS A CLASSIFICATION 4C ACCESS ROAD AND

- THE FOLLOWING MODIFIED REQUIREMENTS:
 ALL-WEATHER CONSTRUCTION;
 LOAD CAPACITY OF AT LEAST 20 TONNES, INCLUDING FOR BRIDGES AND CULVERTS;
- MINIMUM CARRIAGEWAY WIDTH OF 4 METRES;
- MINIMUM VERTICAL CLEARANCE OF 4 METRES;
- MINIMUM HORIZONTAL CLEARANCE OF 0.5 METRES FROM THE EDGE OF THE
- CROSS FALLS OF LESS THAN 3° (1:20 OR 5%); DIPS LESS THAN 7° (1:8 OR 12.5%) ENTRY AND EXIT ANGLE; CURVES WITH A MINIMUM INNER RADIUS OF 10 METRES;
- MAXIMUM GRADIENT OF 15° (1:3.5 OR 28%) FOR SEALED ROADS, AND 10° (1:5.5 OR 18%) FOR UNSEALED ROADS; AND
- TERMINATE WITH A TURNING AREA FOR FIRE APPLIANCES PROVIDED BY ONE OF THE
- A TURNING CIRCLE WITH A MINIMUM INNER RADIUS OF 10 METRES
- A PROPERTY ACCESS ENCIRCLING THE BUILDING; OR A HAMMERHEAD "T" OR "Y" TURNING HEAD 4 METRES WIDE AND 8 METRES L

- FIREFIGHTING WATER SUPPLY TO BE A MIN. 10000L PER BUILDING TO BE PROTECTED. THIS VOLUME OF WATER MUST NOT BE USED FOR ANY OTHER PURPOSE INCLUDING FIRE FIGHTING SPRINKLER OR SPRAY SYSTEMS
- WATER TANK MUST BE METAL, CONCRETE OR LAGGED BY NON-COMBUSTABLE MATERIALS AND ALL ABOVE GROUND PIPES & FITTINGS TO BE MADE FROM NON-RUSTING, NON-COMBUSTIBLE AND NON-DEFORMING MATERIALS
- TANK TO BE LOCATED A MINIMUM 6.0 m FROM DWELLING AND WITHIN 3.0 m OF A HARDSTAND AREA WATER TANK OR CONNECTION POINT TO BE FITTED WITH A MALE 64mm 5v THREAD COUPLING WITH MINIMUM DELIVERY OF 270L PER MINUTE

ISSUED FOR APPROVAL

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Client: M. & J. SPAULDING

Project: PROPOSED DWELLING

Date Drawn: 05.09.25 Address: 60 VETERANS ROW WESTBURY TAS 7303

ENGINEERING

Rev

D

PLUS BUILDING DESIGN
PROJECT MANAGEMENT
CIVIL/STRUCTURAL ENG

Drawing No:

2025-254 A01 / A09

Version: 1, Version Date: 29/10/2025

D MINOR AMENDMENT MINOR AMENDMENT MINOR AMENDMENT

28.10.25 K.Y. 20.10.25 K.Y. Approved: J. Pfeiffer Scale: As Shown @ A3 Mob 0417 362 783 or 0417 545 813 jack@engineeringplus.com.au trin@engineeringplus.com.au A ISSUED FOR APPROVAL

LEGEND

STORMWATER

STORMWATER FROM PROPOSED DWELLING TO BE DIRECTED INTO EXISTING STORWATER SYSTEM

TO LOCAL COUNCIL REQUIREMENTS & AS3500

<u>DRAINAGE</u> ALL DRAINAGE WORK SHOWN IS PROVISIONAL

COMPLY WITH THE REQUIREMENTS OF THE LOCAL AUTHORITIES. ALL WORK IS TO COMPLY WITH THE REQUIREMENTS OF NATIONAL PLUMBING AND DRAINAGE CODE AS3500 AND

MUST BE CARRIED OUT BY A LICENCED

TRADESMAN ONLY.


ONLY AND IS SUBJECT TO AMENDMENT TO

10.10.25 W.T Accredited Building Designer


Drawn: W. Tan

Checked: C. Lim

05.09.25 W.T. Designer Name: J.Pfeiffer Date: Int: Accreditation No: CC2211T

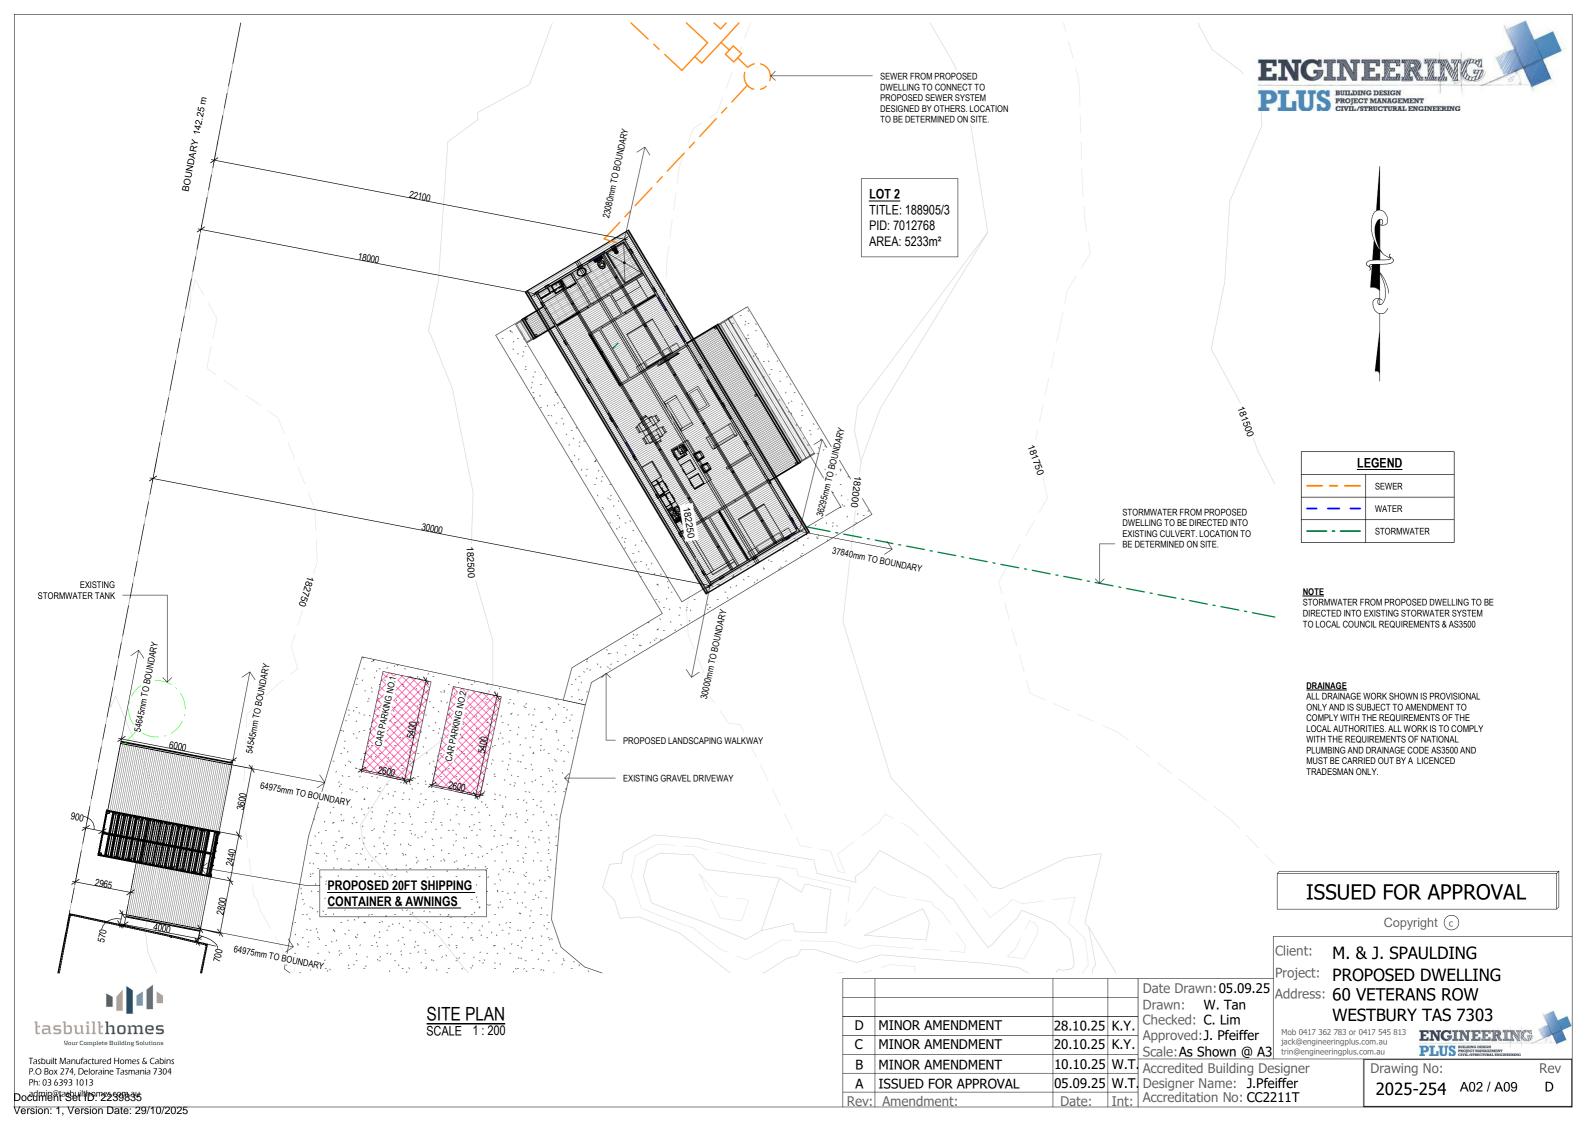



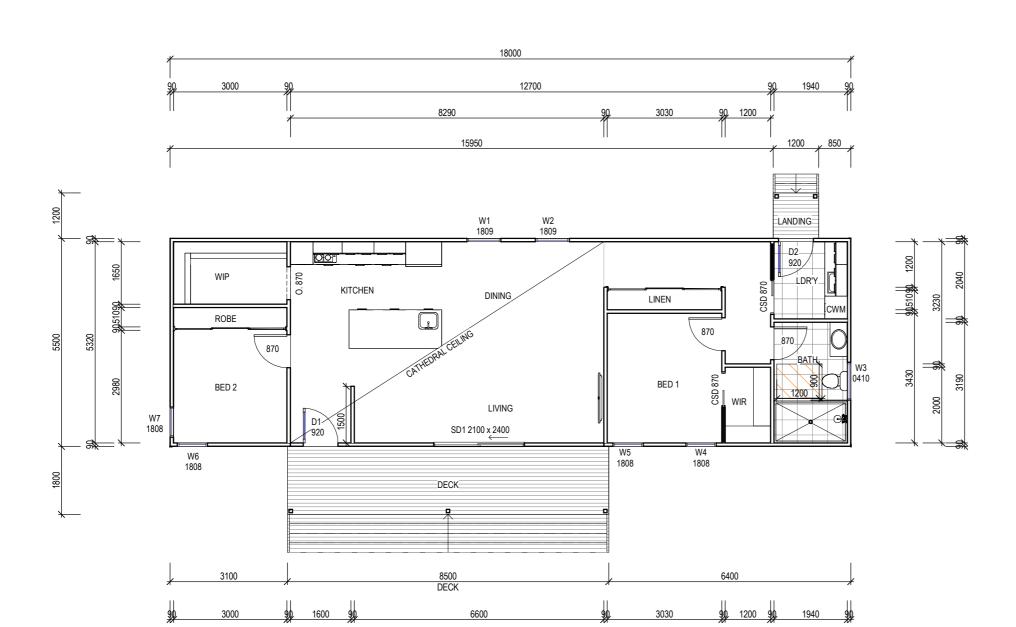





WINDOW SCHEDULE

MARK HEIGHT	WIDTH TYPE	U-VALUE SHGC

W1	1800	900	DG	4.3	.55
W2	1800	900	DG	4.3	.55
W3	400	1000	DG	4.3	.55
W4	1800	800	DG	4.3	.55
W5	1800	800	DG	4.3	.55
W6	1800	800	DG	4.3	.55
W7	1800	800	DG	4.3	.55
SD1	2100	2400	DG	4.0	.61
D1	2100	920	DG	4.0	.61
D2	2100	920	DG	4.0	.61
W6 W7 SD1 D1	1800 1800 2100 2100	800 800 2400 920	DG DG DG	4.3 4.3 4.0 4.0	.55 .55 .61

DISCLAIMER:

ALL WINDOWS SHOWN ON PLAN ARE APPROX. BASED OFF STANDARD MANUFACTURING SIZES. ALL WINDOW DIMENSIONS TO BE CONFIRMED ON SITE BY BUILDER PRIOR TO ORDERING AND MANUFACTURING.

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Area Schedule (Gross Building)

Name Area Area (sq) DWELLING 99.00 m² 10.66 DECK 15.30 m² 1.65 LANDING 1.44 m² 0.16 PROPOSED 20FT SHIPPING CONTAINER & AWNINGS 47.61 m² 5.13 163.35 m² 17.58

				!	roject
				Date Drawn: 05.09.25	Addres
				Drawn: W. Tan	laares
D	MINOR AMENDMENT	28.10.25		Checked: C. Lim	Mob 0417
С	MINOR AMENDMENT	20.10.25		Approved: J. Pfeiffer Scale: As Shown @ A3	jack@eng trin@engi
В	MINOR AMENDMENT	10.10.25	W.T.	Accredited Building Des	
Α	ISSUED FOR APPROVAL	05.09.25	W.T.	Designer Name: J.Pfei	iffer
Rev:	Amendment:	Date:	Int:	Accreditation No: CC22	11T

Drawn: W. Tan Checked: C. Lim Approved: J. Pfeiffer Scale: As Shown @ A3 trin@engineeringplus.com.au

Project: PROPOSED DWELLING Date Drawn: 05.09.25 Address: 60 VETERANS ROW WESTBURY TAS 7303

Client: M. & J. SPAULDING

Mob 0417 362 783 or 0417 545 813 jack@engineeringplus.com.au

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PLUS BUILDING DESIGN
PROJECT MANAGEMENT
CIVIL/STRUCTURAL ENGIS

Drawing No:

2025-254 A03 / A09

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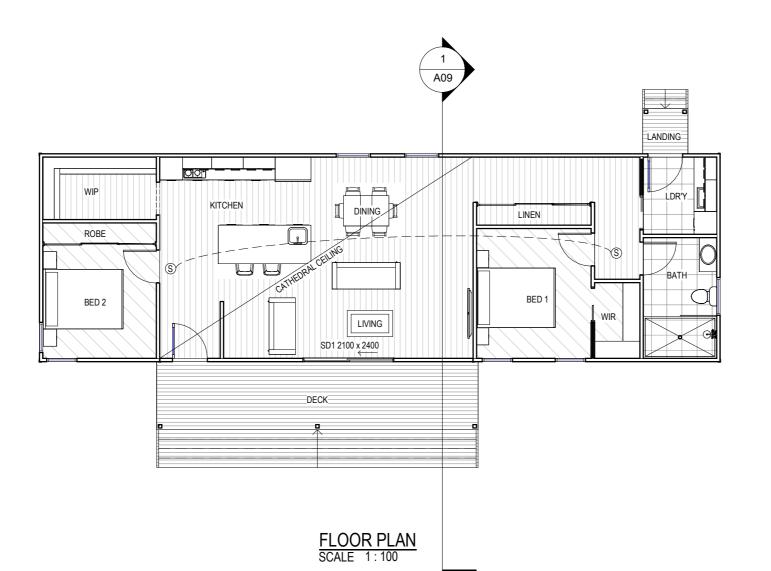
Tasbuilt Manufactured Homes & Cabins


P.O Box 274, Deloraine Tasmania 7304

Ph: 03 6393 1013







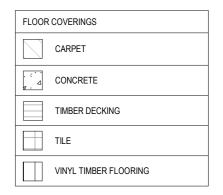

SMOKE ALARMS PROVIDE AND INSTALL SMOKE ALARMS & HARD WIRE TO BUILDING POWER SUPPLY TO AS 3786. CEILING MOUNTED WITH 9VDC ALKALINE BATTERY BACKUP TO LOCATIONS INDICATED ON PLAN AND IN ACCORDANCE WITH NCC PART H3D6 - ACBC PART 9.5

S - DENOTES INTERCONNECTED SMOKE DETECTORS

Area Schedule (Gross Building) Name Area (sq) Area **DWELLING** 99.00 m² 10.66 DECK 15.30 m² 1.65 LANDING 0.16 1.44 m² PROPOSED 20FT SHIPPING 47.61 m² 5.13 CONTAINER & AWNINGS 163.35 m² 17.58

Drawn: W. Tan Checked: C. Lim D MINOR AMENDMENT 28.10.25 K.Y. Approved: J. Pfeiffer Scale: As Shown @ A3 Mob 0417 362 783 or 0417 545 813 jack@engineeringplus.com.au trin@engineeringplus.com.au

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05.09.25 W.T. Designer Name: J.Pfeiffer

Date: Int: Accreditation No: CC2211T

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Project: PROPOSED DWELLING Date Drawn: 05.09.25 Address: 60 VETERANS ROW

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Drawing No: 2025-254 A04 / A09

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Documentaseille

Version: 1, Version Date: 29/10/2025

EAVE & SOFFIT CONSTRUCTION ABCB Volume 2 PART 7.4.5 EAVE WIDTH - 300MM

COLORBOND 'CUSTOM ORB' ROOFING TO

5.00°

CEILING LEVEL

FLOOR LEVEL

AHD ± 183.00m

ENSURE FALL HEIGHT OF LESS THAN

1000mm UPON COMPLETION PROVIDE

FARTHWORK TO REDUCE HEIGHT OR

PROVIDE BALUSTRADE TO NCC STANDARDS.


OWNERS COLOUR SPECIFICATIONS.

-_{19.50°}

SOFFIT / EAVE LINED WITH 'HARDIFLEX' CEMENT SHEETING

- TRIMMERS LOCATED WITHIN 1200 MM OF EXTERNAL CORNERS TO BE SPACED @ 500 MM CENTERS, REMAINDER OF SHEET 700 MM CENTERS
- FASTENER / FIXINGS WITHIN 1200 MM OF EXTERNAL CORNERS @ 200 MM CENTERS, REMAINDER OF SHEET 300 MM CENTERS



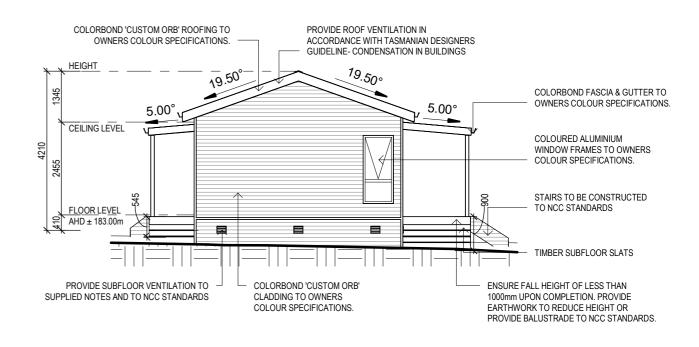

SOUTH EAST ELEVATION SCALE 1:100

STAIR CONSTRUCTION. ABCB Volume 2 PART II.2

TREADS: 240 MM RISERS: 180 MM

TREATED PINE TIMBER STAIR MATERIAL TO ASI684

- TREATMENT LEVELS H4 FOR INGROUND USE & H3 FOR ABOVE GROUND USE.
- ALL FIXINGS FITTING BRACKETS AND CONNECTORS TO BE GALVANISED.
- STRINGER: 300X50 F5 TREATED PINE
- TREADS: 240x45 F5 TREATED PINE MAXIMUM TREAD SPAN 1000

NORTH WEST ELEVATION

COLORBOND 'CUSTOM ORB'

CLADDING TO OWNERS

COLOUR SPECIFICATIONS

PROVIDE ROOF VENTILATION IN

ACCORDANCE WITH TASMANIAN DESIGNERS

5.00°

PROVIDE SUBFLOOR VENTILATION TO

SUPPLIED NOTES AND TO NCC STANDARDS

COLORBOND FASCIA & GUTTER TO OWNERS COLOUR SPECIFICATIONS.

COLOURED ALUMINIUM

WINDOW FRAMES TO OWNERS COLOUR SPECIFICATIONS.

STAIRS TO BE CONSTRUCTED TO NCC STANDARDS

TIMBER SUBFLOOR SLATS

GUIDELINE- CONDENSATION IN BUILDINGS



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Documentasty in 1922 59835

Version: 1, Version Date: 29/10/2025

Drawn: W. Tan Checked: C. Lim D MINOR AMENDMENT 28.10.25 K.Y. Approved: J. Pfeiffer C MINOR AMENDMENT Scale: As Shown @ A3 trin@engineeringplus.com.au 10.10.25 W.T Accredited Building Designer B MINOR AMENDMENT 05.09.25 W.T. Designer Name: J.Pfeiffer A ISSUED FOR APPROVAL Date: Int: Accreditation No: CC2211T

Rev: Amendment:

Copyright © Client: M. & J. SPAULDING

Project: PROPOSED DWELLING Date Drawn: 05.09.25 Address: 60 VETERANS ROW **WESTBURY TAS 7303**

Mob 0417 362 783 or 0417 545 813 **ENGINEERING** jack@engineeringplus.com.au

PLUS BUILDING DESIGN
PROJECT MANAGEMENT
GIVIL/STRUCTURAL ENGIN

Drawing No:

ISSUED FOR APPROVAL

2025-254 A05 / A09

Rev

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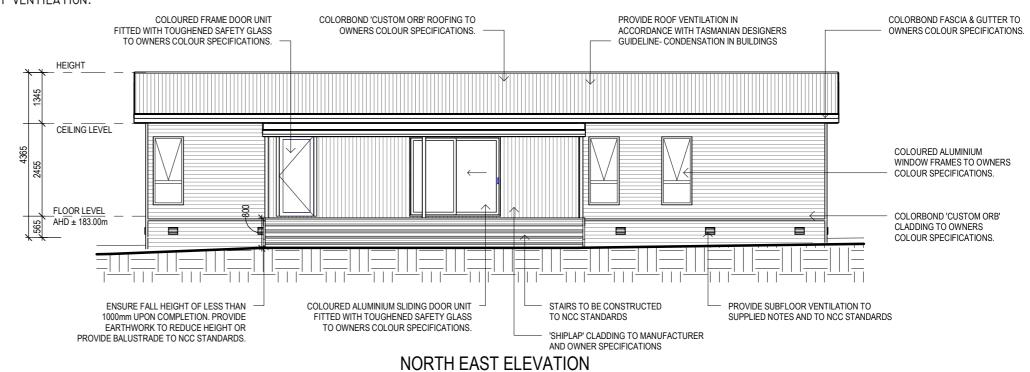
SUB FLOOR VENTILATION. NCC VOL 2 PART 6.2.1


- A MINIMUM OF 150 MM OF SUB FLOOR CLEARANCE IS TO BE PROVIDED BETWEEN FINISHED SURFACE LEVEL & THE UNDERSIDE OF THE FLOOR BEARER.
- A MINIMUM OF 6000 MM2 PER METRE OF SUB FLOOR VENTILATION IS TO BE UNIFORMLY DISTRIBUTED AROUND THE EXTERNAL AND INTERNAL WALLS OF THE BUILDING.
- VENTS TO BE LOCATED NO GREATER THAN 600 MM FROM AN INTERNAL OR EXTERNAL CORNER.

PRYDA 230x75 - 52 HOLE VENT MAXIMUM SPACING 1050 MM ALONG WALL OR PRYDA 230x165 - 117 HOLE VENT MAXIMUM SPACING 2350 MM ALONG WALL

ADDITIONAL VENTILATION PROVISIONS TO BE INSTALLED WHERE OBSTRUCTIONS SUCH AS CONCRETE VERANDAH'S, DECKS, PATIOS AND PAVING ARE INSTALLED & OBSTRUCT VENTILATION.





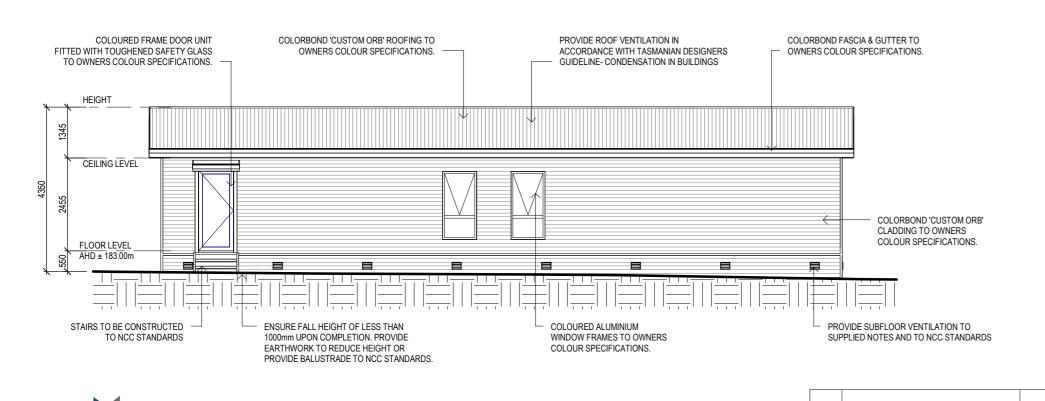

SELECTED ALUMINIUM FRAMED WINDOWS - ABCB VOLUME 2 PART 8.3

POWDER COATED ALUMINIUM WINDOW & DOOR FRAMES, UNLESS OTHERWISE

PRIMED PINE REVEALS AND TRIMS. ALL FLASHING AND FIXINGS TO MANUFACTURERS SPECIFICATIONS.

GLAZING & FRAME CONSTRUCTION TO AS 2047 & AS 1288 ALL FIXINGS AND FLASHINGS TO MANUFACTURERS REQUIREMENTS

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M. & J. SPAULDING Project: PROPOSED DWELLING

Date Drawn: 05.09.25 Address: 60 VETERANS ROW WESTBURY TAS 7303

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Version: 1, Version Date: 29/10/2025

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SOUTH WEST ELEVATION

Drawn: W. Tan Checked: C. Lim D MINOR AMENDMENT 28.10.25 K.Y. Approved: J. Pfeiffer MINOR AMENDMENT 10.10.25 W.T Accredited Building Designer MINOR AMENDMENT A ISSUED FOR APPROVAL

Rev: Amendment:

05.09.25 W.T. Designer Name: J.Pfeiffer


Date: Int: Accreditation No: CC2211T

2025-254 A06 / A09

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ROOF PLAN SCALE 1:100

ROOF CLADDING. NCC PART 7.2 SHEET ROOFING

COLORBOND 'CUSTOM ORB' METAL SHEETING INSTALLED IN ACCORDANCE WITH THIS PART, AS 1562.1 AND MANUFACTURERS RECOMMENDATIONS.

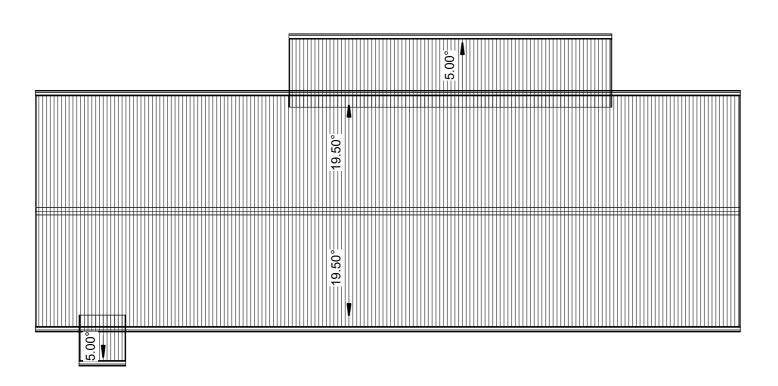COLORBOND 'TRIMDEK' METAL SHEETING INSTALLED IN ACCORDANCE WITH THIS PART, AS 1562.1 AND MANUFACTURERS RECOMMENDATIONS.

REFER TO LYSAGHT ROOFING & WALLING MANUAL FOR FULL DETAILS ON SHEET INSTALLATION, FIXINGS & FLASHINGS

COLORBOND 'CUSTOM ORB'

- MINIMUM PITCH 5 DEGREES.
- CORROSION PROTECTION IN ACCORDANCE WITH BCA TABLE 3.5.1.1.
- END LAP OF SHEETS

5-15 DEGREES - MINIMUM 200MM.

ABOVE 15 DEGREES - MINIMUM 150 MM.

Drawn: W. Tan

Checked: C. Lim

10.10.25 W.T Accredited Building Designer

05.09.25 W.T. Designer Name: J.Pfeiffer

Date: Int: Accreditation No: CC2211T

Approved: J. Pfeiffer

28.10.25 K.Y.

D MINOR AMENDMENT

C MINOR AMENDMENT

B MINOR AMENDMENT

Rev: Amendment:

A ISSUED FOR APPROVAL

- RIDGE LINE VALLEY TO BE TURNED UP (STOP ENDED).
- FASTENERS TO BE MADE OF COMPATIBLE MATERIAL WITH ROOFING MATERIAL.
- CREST FIXINGS OF END SPANS @ EVERY SECOND RIB AND INTERNAL SPANS @ EVERY THIRD RIB.
- WHERE POSSIBLE SHEETS TO BE LAID WITH SIDE LAPS FACING AWAY FROM PREVAILING WEATHER.
- REFLECTIVE FOIL INSULATION TO BE FITTED TO UNDERSIDE OF SHEETS.

R4.0 INSULATION BATTS TO ROOF SPACE ABOVE CEILING LINING.

RECOMMENDED FIXINGS FOR SEVERE EXPOSURE CONDITIONS TO AS 3566

USE CLASS 4 MATERIALS FOR SEVERE EXPOSURE & STAINLESS STEEL FOR VERY SEVERE COASTAL ENVIRONMENTS.

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Client: M. & J. SPAULDING

Project: PROPOSED DWELLING Date Drawn: 05.09.25 Address: 60 VETERANS ROW

Scale: As Shown @ A3 trin@engineeringplus.com.au

WESTBURY TAS 7303 Mob 0417 362 783 or 0417 545 813 jack@engineeringplus.com.au **ENGINEER IN 13**

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PLUS BUILDING DESIGN
PROJECT MANAGEMENT
CIVIL/STRUCTURAL ENGI

Drawing No: 2025-254 A07 / A09

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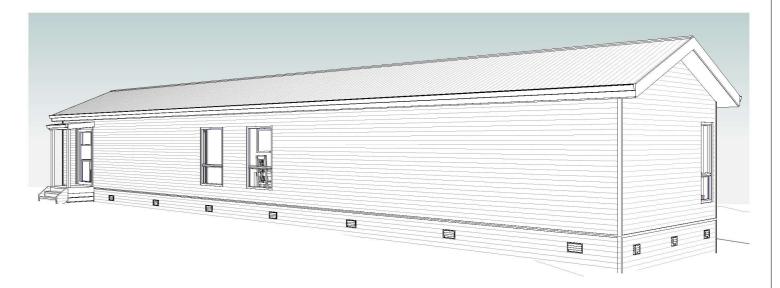
Tasbuilt Manufactured Homes & Cabins P.O Box 274, Deloraine Tasmania 7304


Ph: 03 6393 1013

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Drawn: W. Tan

05.09.25 W.T. Designer Name: J.Pfeiffer
Date: Int: Accreditation No: CC2211T

28.10.25 K.Y. Checked: C. Lim

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28.10.25 K.Y.

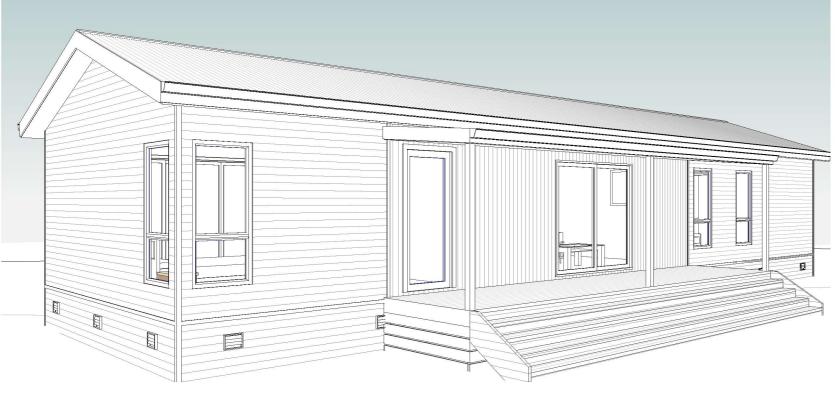Approved: J. Pfeiffer Scale: As Shown @ A3 trin@engineeringplus.com.au PLUS MODERATION NO:

10.10.25 W.T.

Accredited Building Designer Drawing No:

2025-254 A08 / A09

Rev

D

Tasbuilt Manufactured Homes & Cabins P.O Box 274, Deloraine Tasmania 7304 Ph: 03 6393 1013

tasbuilthomes

1111

Documentastelling. 2259835 Version: 1, Version Date: 29/10/2025



June 2025

PLANNING REPORT

DEVELOPMENT OF A SINGLE DWELLING AND OUTBUILDINGS

56 Dexter Street WESTBURY





Prepared by
Woolcott Land Services Pty Ltd
ABN 63 677 435 924

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Launceston

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Woolcott Land Services & East Coast Surveying 56 Dexter Street WESTBURY

Job Number: L250817

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(BUrbRegEnvPlan)

Town Planner

Rev.no	Description	Date
1	Review	
2	Draft	27 October 2015
3	Final	29 October 2015

References

Annexures

Annexure 1 Copy of Title plan and Folio text

Annexure 2 Proposal Plan

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1. Introduction

This report has been prepared in support of a planning permit application under Section 57 of the *Land Use Planning and Approvals Act 1993*.

Proposed development

Building and works - development of a single dwelling and outbuilding (partial retrospective)

This application is to be read in conjunction with the following supporting documentation:

Document	Consultant
Proposal Plan	Engineering Plus / Tasbuilt Homes

2. Subject site and proposal

2.1 Site details

Address	56 Dexter Street, Westbury TAS 7303
Property ID	7012768
Title	188905/3
Easements	None
Land area	5233m ²
Planning Authority	Meander Valley Council
Planning Scheme	Tasmanian Planning Scheme – Meander Valley (Scheme)
Application status	Discretionary application
Existing Access	Single vehicle crossing from Veterans Row
Zone	Low Density Residential
General Overlay	Westbury Specific Area Plan
Overlays	Bushfire Prone Areas
Existing development	Outbuilding (Container with awnings and shed) (retrospective approval required)
Existing services and infrastructure	

Water	Serviced
Sewer	Not serviced
Stormwater	Public connection

2.2 Proposal

The proposal is for the development of a single dwelling and approval for one outbuilding (container) with two awnings.

The proposed dwelling will have 2 bedrooms, 1 bathroom, living area, kitchen and laundry and will include a decked area. The building has an area of 99m².

The outbuilding is built around a container that is dimensioned $6.06m(L) \times 2.44m(W)$ and 2.59m(H). The awing structures are lower in height that the container. The outbuilding will be connected to a stormwater tank that is 1.3m in height with a diameter of 2.6m. The outbuilding and water tank, as a cluster have a rear setback of 0.9m from the rear boundary.

The outbuilding is intended for residential use associated with the proposed dwelling.

The proposal includes connection for water and stormwater. Wastewater will be managed on site.

The site has an existing vehicle crossing. The existing driveway and parking are included to the plans.

2.3 Subject site

The site is a single lot of 5233m² with frontage of 69.7m, accessed from Veterans Row, which is a Council maintained unsealed road. The lot includes a 'handle' to allow water connection to Dexter Street over the title. The subject site is flat and even.



Figure 1 Aerial view of the subject site (Source: LIST)

3. Zoning and overlays

3.1 Zoning

The site is zoned Low Density Residential under the Scheme.

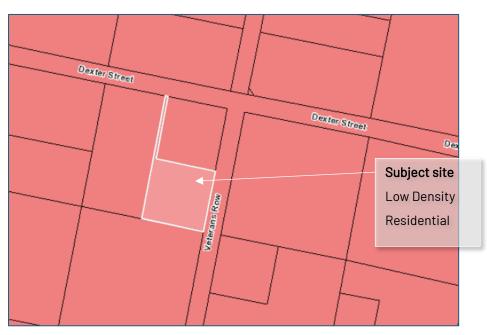


Figure 2 Zoning of the subject site and surrounding area (Source: LIST)

3.2 Overlays

The subject site is affected by the Bushfire Prone Areas overlay.

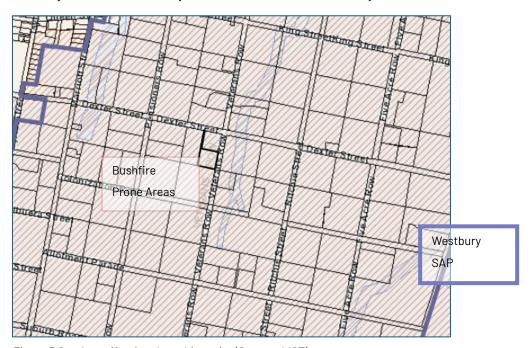


Figure 3 Overlays affecting the subject site (Source: LIST)

4. Planning Scheme Assessment

4.1 Zone assessment

MEA-S11.0 Westbury Specific Area Plan

MEA-S11.1 Plan Purpose

This clause is in substitution for Low Density Residential Zone - clause 10.2 Use Table.

MEA- S11.1.1	To provide for a subdivision density and the arrangement of future development in Westbury.
MEA- S11.1.2	To provide for additional lot yield without diminishing the historic, low density grid arrangement of lots and roads.
MEA- S11.1.3	To provide for subdivision that facilitates separation distances between dwellings, consistent with the existing dwelling separation character.
MEA- S11.1.4	To locate and design development to reinforce the low density character of the streetscape through building separation and minimizing, or mitigating, viewing opportunities from the road.
MEA- S11.1.5	To locate and design development to reinforce the low density residential character of the area through separation of buildings, and minimizing, or mitigating, viewing opportunities between habitable rooms and views of development from adjoining properties or recreational pathways.

Response

The proposed residential use and development is in accord with the purpose of the Plan.

MEA-S11.5 Use Table

This clause is in substitution for Low Density Residential Zone - clause 10.2 Use Table.

No Permit Required	
Residential	If for a single dwelling.

Response

The proposed Use is a No Permit Required Use.

MEA-S11.7 Development Standards for Buildings and Works

MEA-S11.7.1 Setback

Objective

That the siting of development provides for setbacks between dwellings, and between dwellings and other buildings that is compatible with the greater separation distances that make up the low density character of the land within the Westbury Specific Area Plan.

Acceptable Solutions		Performance Criteria		
A1	Buildings must have a setback from a frontage of:	P1	The siting of a building must be compatible with the streetscape and character of	

a) not less than 15m; or development existing on established b) not less than existing buildings, properties in the area, having regard to: excluding outbuildings, on the site. a) the topography of the site; b) the setbacks of surrounding buildings; c) the height, bulk and form of existing and proposed buildings; d) the appearance when viewed from roads; e) mitigation of visual impacts through the retention of any vegetation; f) the ability to screen or offset view lines between dwellings; and g) (g) the safety of road users. Α2 P2 Buildings must have a setback from side The siting of a building must provide for separation distances compatible with the low and rear boundaries: density character of development existing on a) not less than 15m; or established properties in the area, having b) not less than existing buildings, regard to: excluding outbuildings, on the site. a) the topography of the site; the setbacks of surrounding buildings; c) the height, bulk and form of existing and proposed buildings; d) impacts on sunlight to private open space and windows of habitable rooms on adjoining properties; e) the appearance when viewed from roads or recreational pathways; f) the ability to screen or offset view lines between dwellings for privacy or visual

Response

- A1 The acceptable solution is achieved.
- P2 The performance criteria apply. The proposed container (outbuilding) has a reduced setback to the rear boundary.
 - a. The site is flat and has no particular bearing on the setback.
 - b. There are very few surrounding buildings to compare to; the subject site appears to be on land recently subdivided.

impacts: and

g) mitigation of visual impacts through the retention of any vegetation.

- c. The proposal includes a single dwelling that will be together with the proposed outbuilding on the lot. The overall size of outbuilding is reasonable in a rural residential environment.
- d. The outbuilding is located to have distance to the dwelling at 56 Dexter Street, and a potential dwelling at the northern adjoining vacant lot.
- e. The view from the road will be as typical for a rural residential environment. The shed is set towards the rear boundary from the road and the dwelling will be the prominent built form.
- f. The outbuilding is not anticipated to create privacy issues.
- g. No additional vegetation is proposed in regard to the reduced setback.

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Figure 5 Outbuilding - container with two awnings. Fenced pen/yard is visible to the left of outbuilding.



Figure 4 Detail of outbuilding structure

10.0 Low Density Residential Zone

10.1 Zone Purpose

10.1.1 To provide for residential use and development in residential areas where there are infrastructure or environmental constraints that limit the density, location or form of development

10.1.2 To provide for non-residential use that does not cause an unreasonable loss of amenity, through

scale, intensity, noise, traffic generation and movement, or other off site impacts.

10.1.3 To provide for Visitor Accommodation that is compatible with residential character.

Response

The proposed residential use and development is in accord with the purpose of the zone.

10.4 Development Standards for Dwellings

10.4.2 Building height

Objective

That the height of dwellings is compatible with the streetscape and do not cause an unreasonable loss of amenity for adjoining properties.

Acceptable Solutions		Performance Criteria			
A1	A dwelling must have a building height not more than 8.5m.	P1 The height of dwellings must be compatible with the streetscape and not cause an unreasonable loss of amenity to adjoining properties having regard to:		the streetscape and not cause an asonable loss of amenity to adjoining	
			a)	the topography of the site;	
			b)	the height of buildings on the site and adjacent properties;	
			c)	the bulk and form of existing and proposed buildings;	
			d)	sunlight to habitable rooms and private open space of dwellings; and	
			e)	any overshadowing of adjoining properties.	

Response

A1 The acceptable solution is achieved.

10.4.3 Setback

Objective			
That the siting of dwellings is compatible with the streetscape and does not cause an unreasonal amenity for adjoining properties.			
Acceptable Solutions	Performance Criteria		
A1 Dwellings, excluding protrusions that extend not more than 0.9m into the frontage setback, must have a setback from a frontage not less than 8m	P1 The siting of a dwelling must be compatible with the streetscape and character of development existing on established properties in the area, having regard to:		
	a) the topography of the site;		
	b) the setbacks of surrounding buildings;		
	 c) the height, bulk and form of existing and proposed buildings; 		

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d)	the appearance when viewed from roads and public open space adjacent to the site; and
e)	(e) the safety of road users.

Response

Replaced by MEA-S11.7.1 Setback.

A2 Dwellings, excluding outbuildings with a building height of not more than 2.4m and protrusions that extend not more than 0.9m horizontally from the building, must have a setback from side and rear boundaries of	P2 The siting of a dwelling must not cause an unreasonable loss of amenity to adjoining properties, having regard to: a) the topography of the site;			
not less than 5m.	b) the size, shape and orientation of the site;			
	c) the setbacks of surrounding buildings;			
	 the height, bulk and form of existing and proposed buildings; 			
	e) the existing buildings and private open space areas on the site;			
	f) sunlight to private open space and windows of habitable rooms on adjoining properties; and			

g) the character of development existing on established properties in the area.

imposed by existing development;e) the provision for landscaping and private

Response

Objective

Replaced by MEA-S11.7.1 Setback.

10.4.4 Site coverage

25,0000				
That site coverage:				
	a) is consistent with the character of existing development in the area;			
	b) provides sufficient area for private open s	provides sufficient area for private open space and landscaping; and		
	c) assists with the management of stormwater runoff.			
Acceptable Solutions		Performance Criteria		
A1	A1 Dwellings must have a site coverage of not more than 30%.		with	site coverage of dwellings must be consistent that existing on established properties in the having regard to:
			a)	the topography of the site;
			b)	the capacity of the site to absorb runoff;
			c)	the size and shape of the site;
			d)	the existing buildings and any constraints

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open space;
f) the need to remove vegetation; and
g) the site coverage of adjacent properties

Response

A1 The acceptable solution is achieved.

10.4.5 Frontage fences for all dwellings

Objective

The height and transparency of frontage fences:

- a. provides adequate privacy and security for residents;
- b. allows the potential for mutual passive surveillance between the road and the dwelling; and
- c. is reasonably consistent with that on adjoining properties.

Acceptable Solutions	Performance Criteria		
A1 No Acceptable Solution.	P1 A fence (including a free-standing wall) for a dwelling within 4.5m of a frontage must: a) provide for security and privacy, while allowing for passive surveillance of the road; and b) be consistent with the height and transparency of fences in the street, having regard to: i. the topography of the site; and		
	ii. traffic volumes on the adjoining road.		

Response

No front fences are included in this proposal.

4.2 Code Assessment

- C2.0 Parking and Sustainable Transport Code
- C2.5 Use Standards

Response

- A1 The acceptable solution is achieved. There are two spaces provided for on the site which meets the requirement under Table C2.1.
- C2.6 Development standards for buildings and works
- C2.6.1 Construction of parking areas

Response

Please refer to plans supplied.

C2.6.2 Design and layout of parking areas

Response

Please refer to plans supplied.

C2.6.3 Number of accesses for vehicles

Response

A1 The site has an existing single access point.

5. Conclusion

This application is for a single dwelling. The proposed is in accord with the provisions of the Scheme and a planning permit is sought from Council.

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